



C1 SHARED WALL SECTION - AREA "B" ROOFS
3/4" = 1'-0"

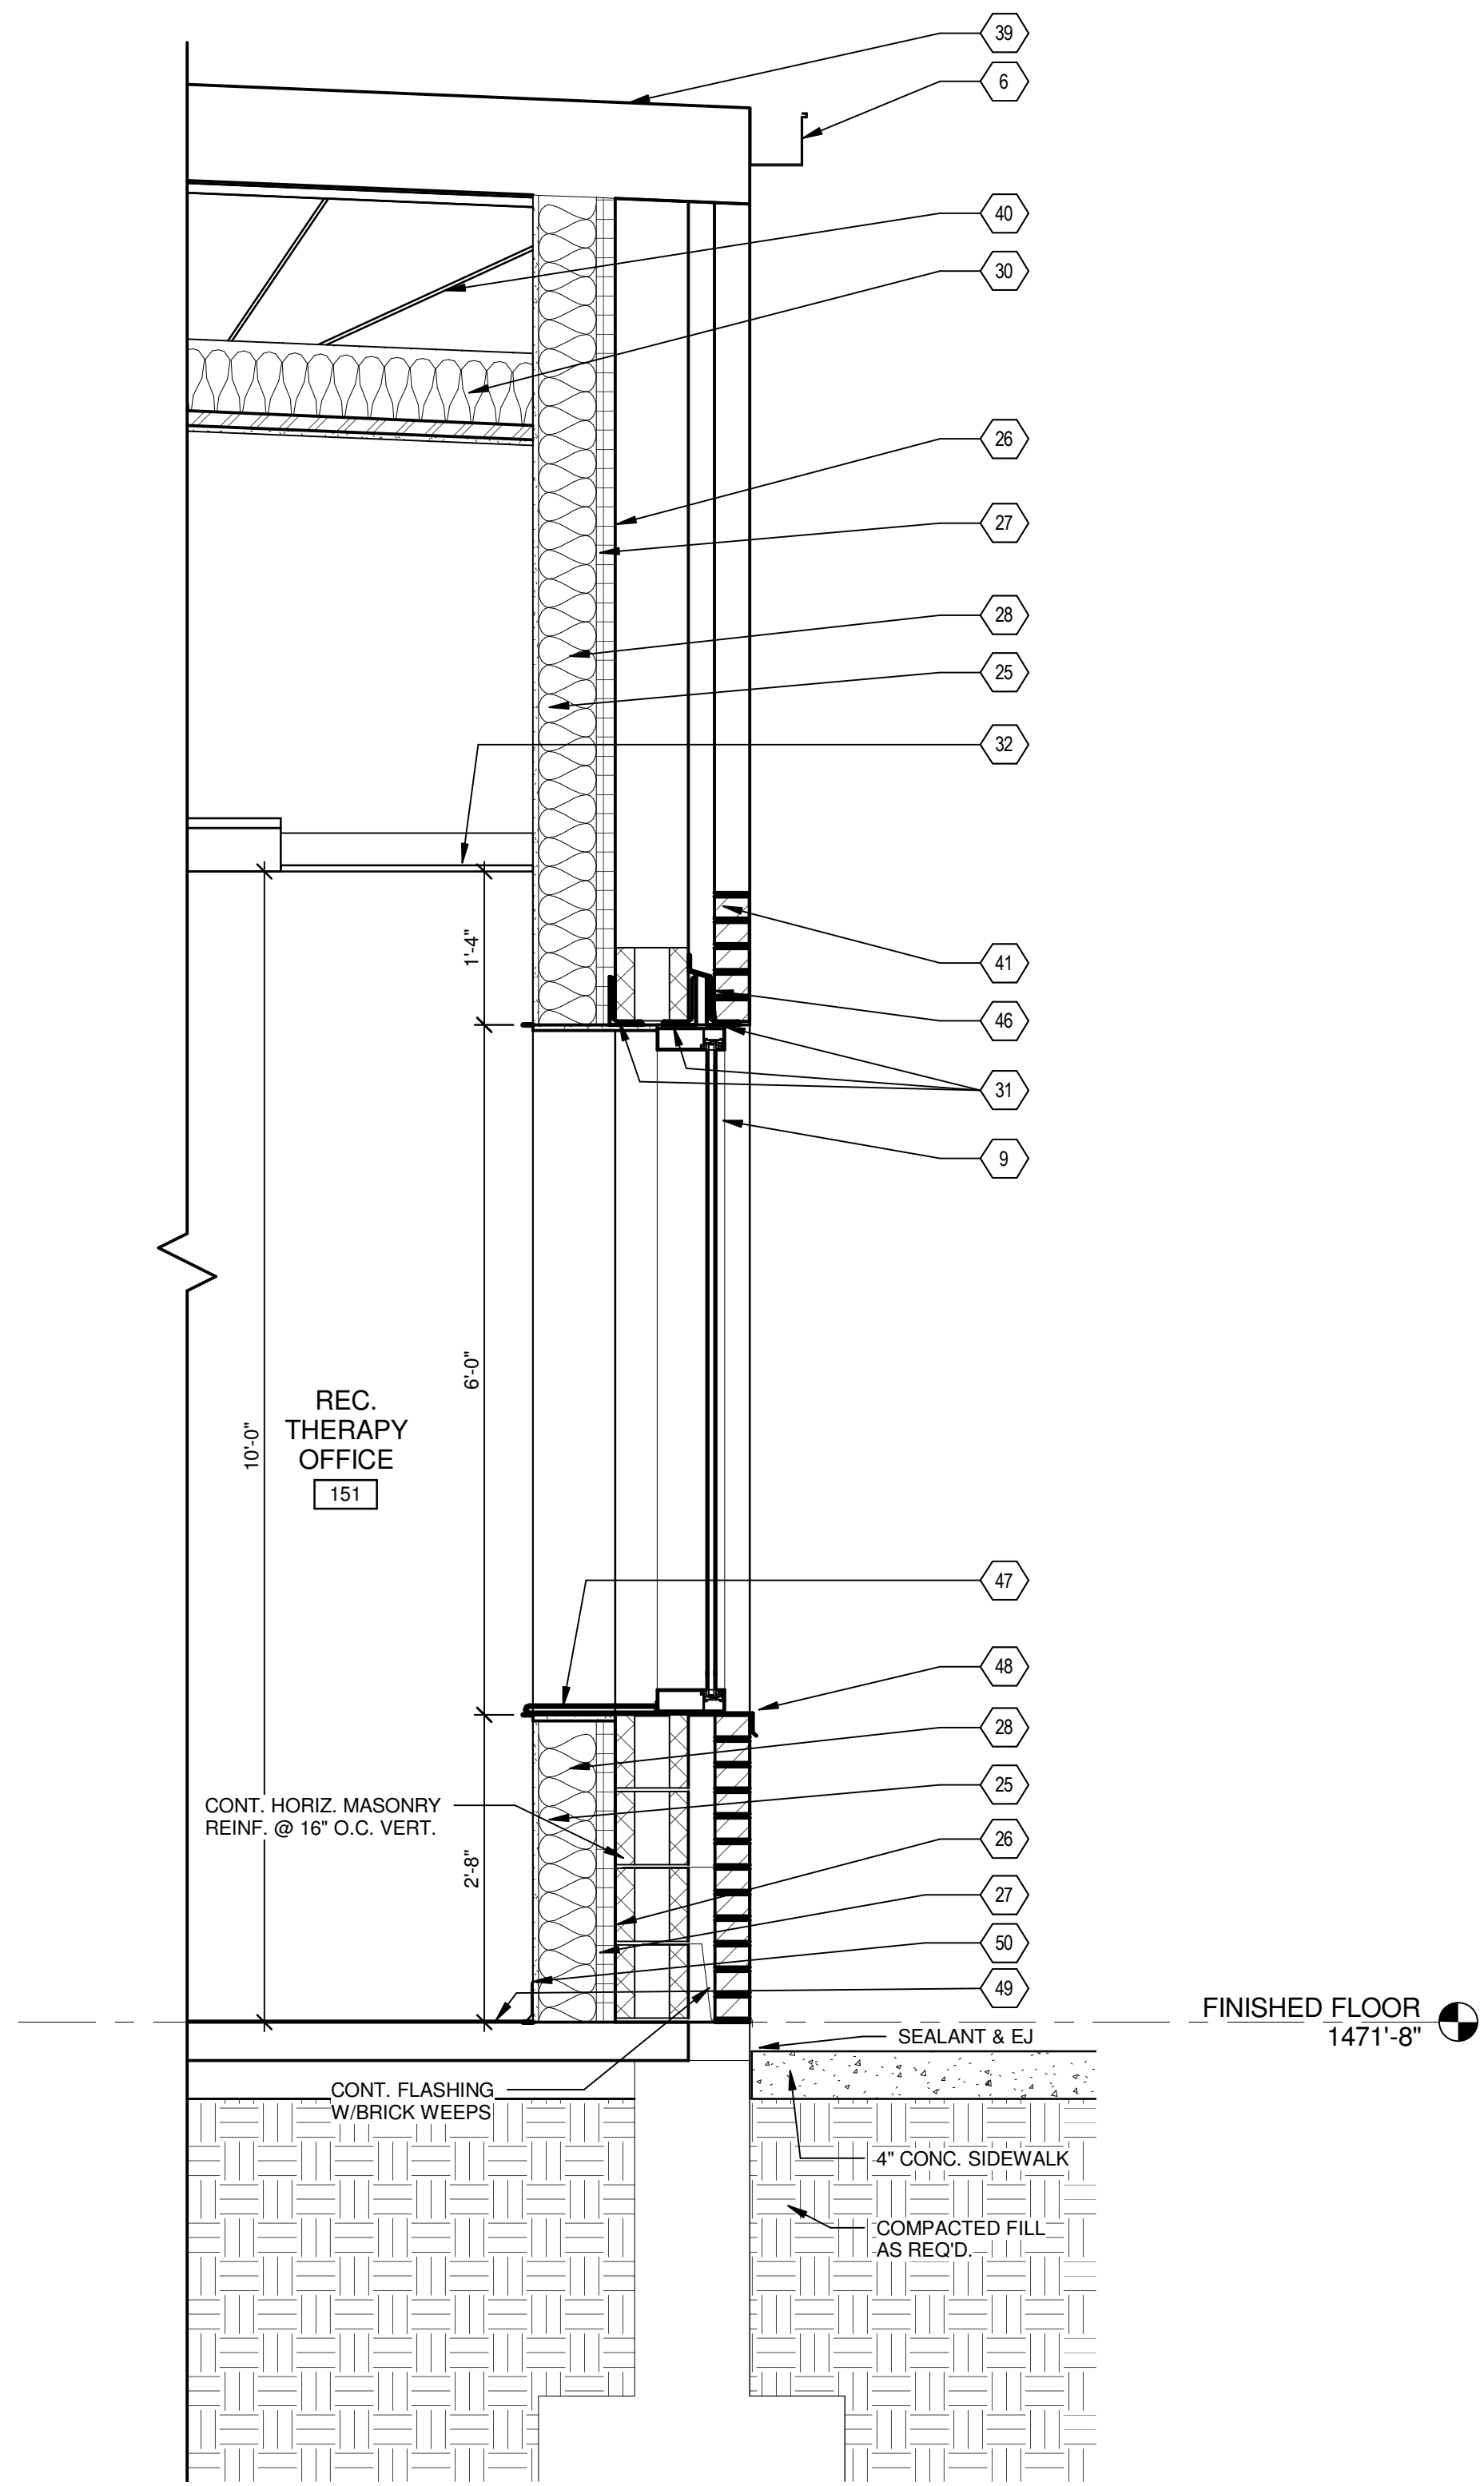

G3 NORTH WALL SECTION - AREA "B" WINDOW
3/4" = 1'-0"

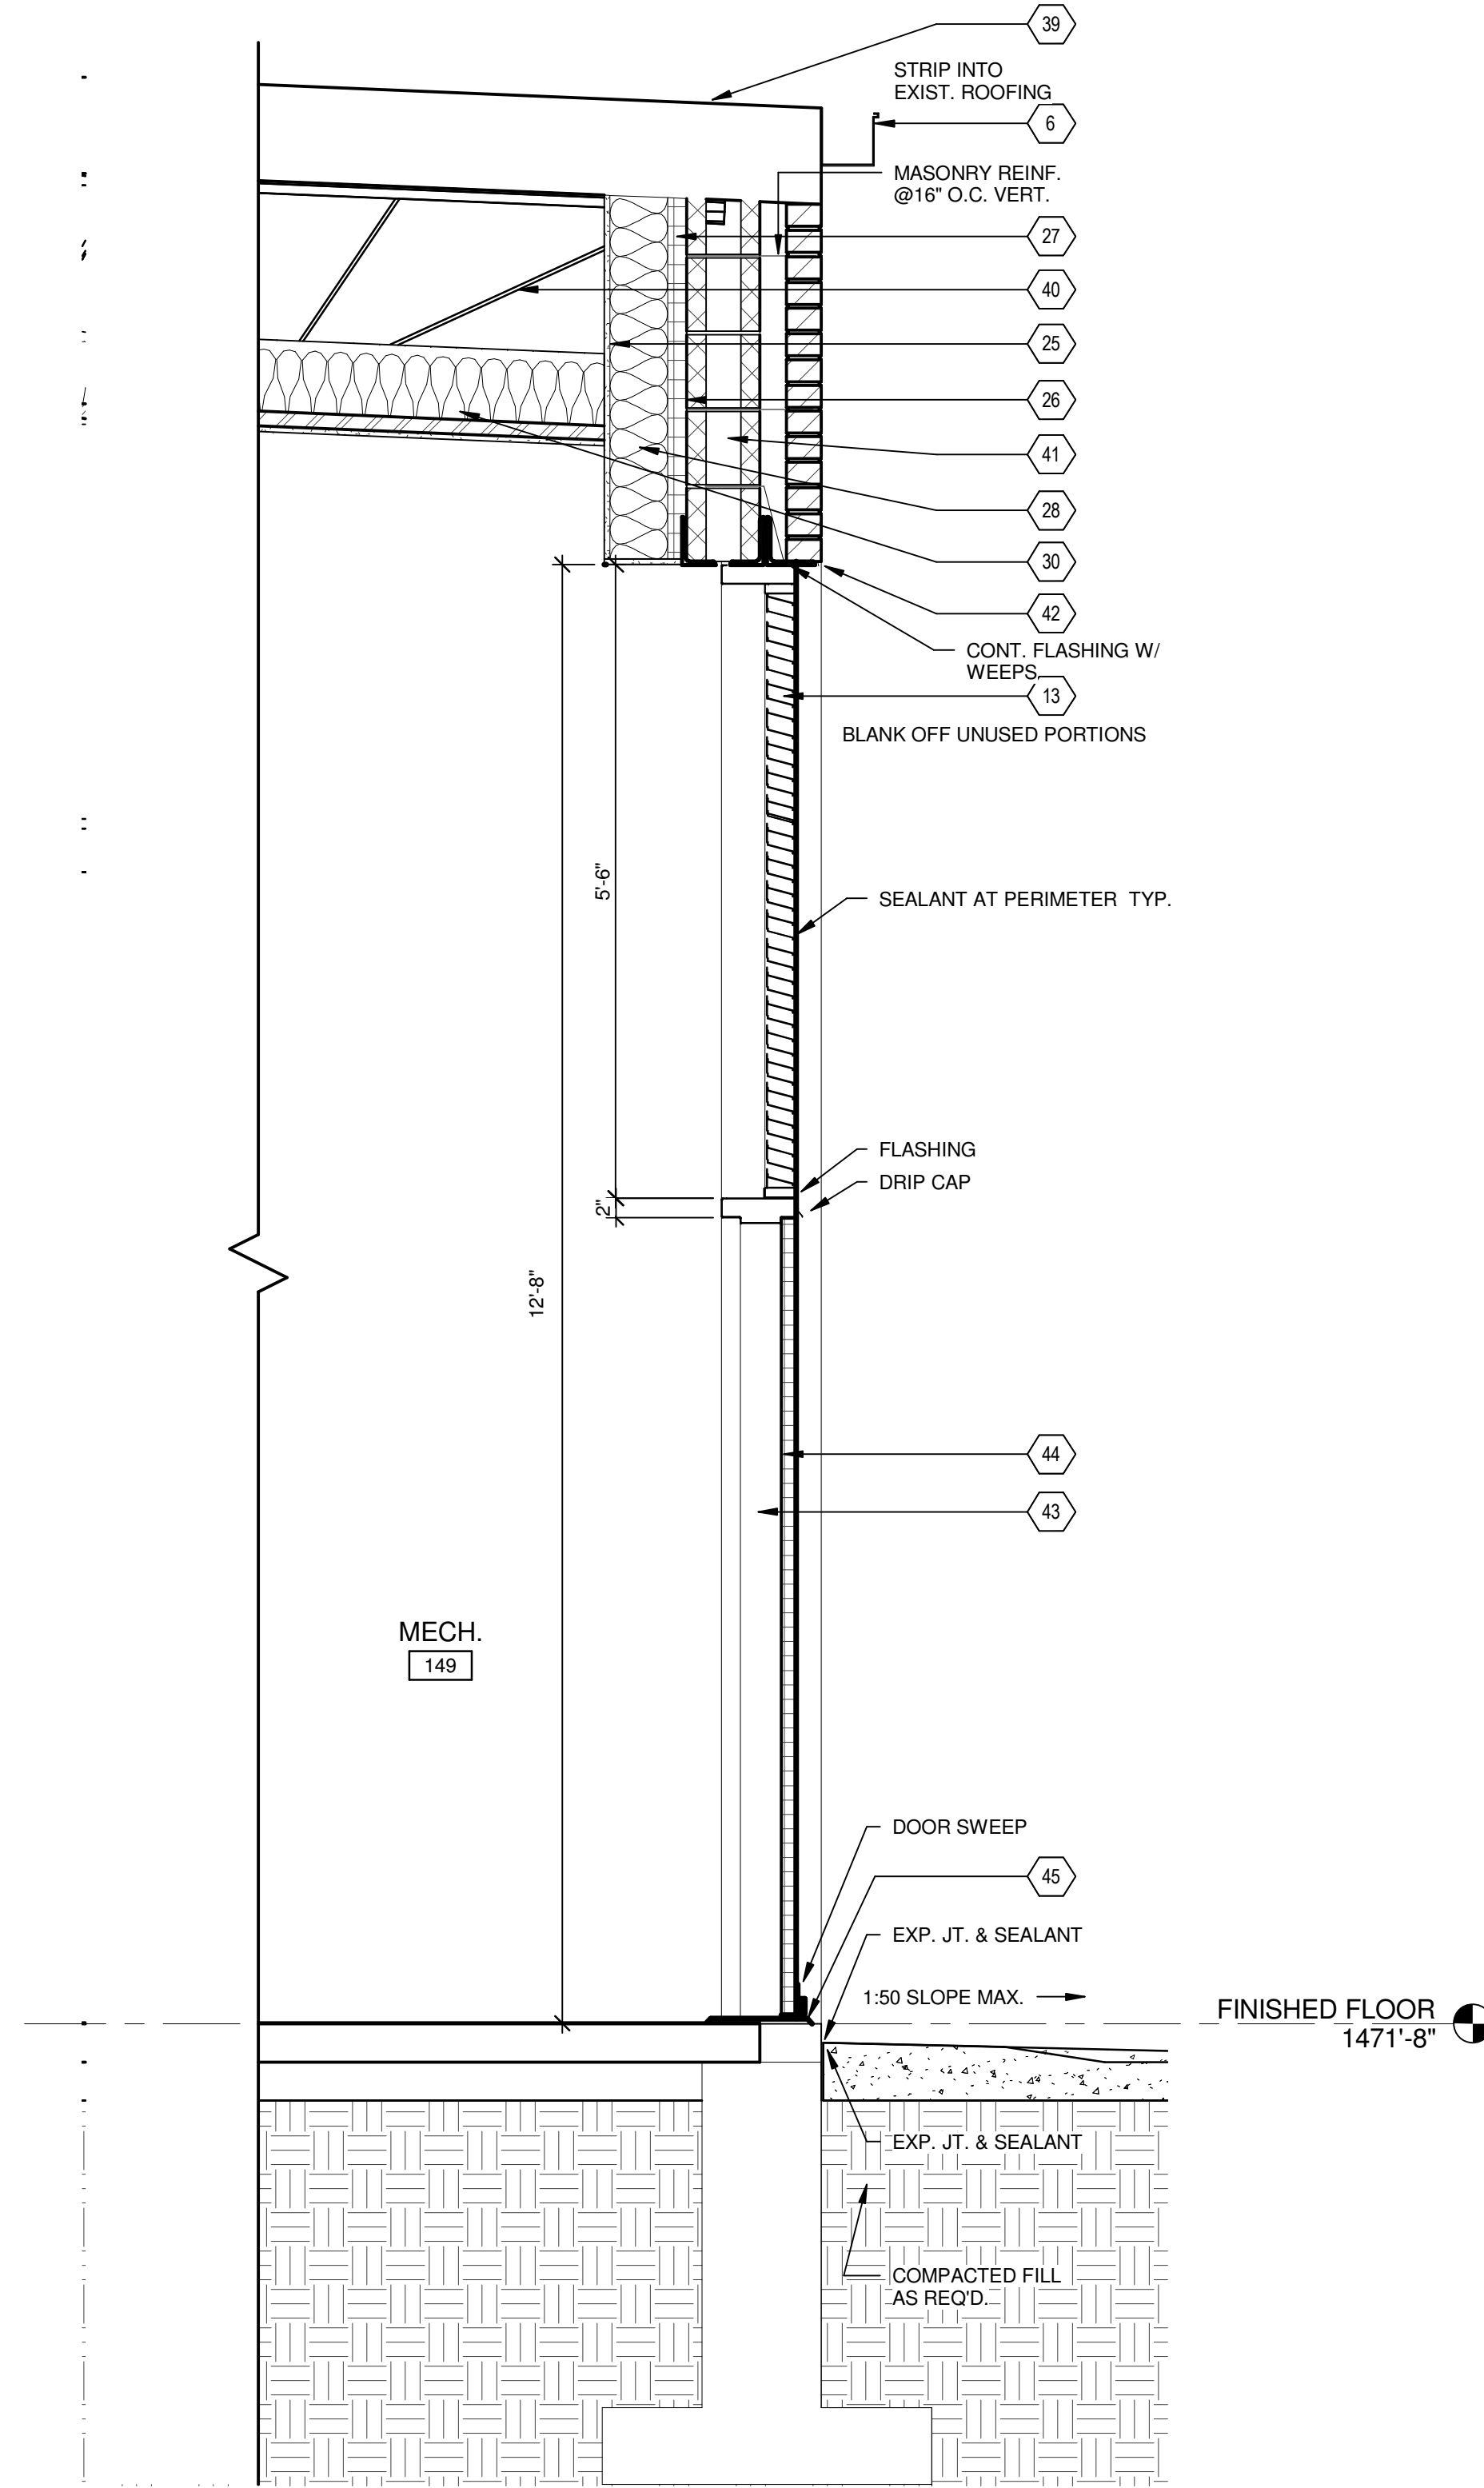

G6 NORTH WALL SECTION - AREA "B" MECHANICAL149
3/4" = 1'-0"

- KEYED WORK NOTES (RE:DETAILS FOR ADDITIONAL INFORMATION)
- 1 NEW BRICK VENEER w/GALV ADJ ANCH SYS 16" OC VERT, 32" OC HORIZ
 - 2 PREFINISHED METAL HORIZONTAL WALL PANELS & TRIM SYSTEM RE: B9/AE501
 - 3 ALUMINUM COMPOSITE METAL (ACM) PANEL SYSTEM
 - 4 PREFINISHED METAL ROOF / WALL FLASHING
 - 5 PREFINISHED METAL FASCIA
 - 6 PREFINISHED METAL GUTTER & DOWNSPOUT (TIE DOWNSPOUTS INTO STORM WATER SYSTEM)
 - 7 PREFINISHED 1-1/2" STANDING SEAM METAL ROOF PANEL
 - 8 ALUMINUM COMPOSITE METAL (ACM) PANEL CANOPY SYSTEM
 - 9 ALUMINUM STOREFRONT SYSTEM, SEE FLOOR PLAN FOR TYPE
 - 10 ALUMINUM ENTRANCE DOOR
 - 11 INSULATED HOLLOW METAL DOOR AND FRAME, PAINT
 - 12 REPLACE EXISTING GUTTER & DOWNSPOUT W/PREFINISHED METAL GUTTER & DOWNSPOUT (TIE DOWNSPOUTS INTO STORM WATER SYSTEM & REPAIR/MODIFY EXISTING ROOF CONNECTION)
 - 13 LOUVER - BLANK OFF UNUSED PORTIONS
 - 14 1-1/2" EXPANSION JOINT AND COVER
 - 15 ICE CLEATS
 - 16 SUNSHADE BY STOREFRONT MANUFACTURER
 - 17 CONTINUOUS ICE AND WATER SHIELD MEMBRANE
 - 18 R-30, 5 1/2" NAIL BASE ROOF INSULATION (EXTEND WD DECK OVER TOP OF FASCIA BLOCKING)
 - 19 1 1/2" GALV METAL ROOF DECK
 - 20 CONTINUOUS BENT PLATE OR ANGLE SUPPORT, RE: STRUC
 - 21 CONTINUOUS TREATED WOOD FRAMING
 - 22 CONTINUOUS PREFINISHED METAL SOFFIT & TRIM RE: B7/AE501
 - 23 1-1/2" GALV METAL "Z" FURRING, 16" O.C., ANCHOR SECURELY TO INSULATED BACKUP PANEL CLIPS PER PANEL MANUF SPECIFICATIONS
 - 24 2" INSULATED-CORE METAL WALL BACKUP PANEL SYSTEM (R-14) W/FLEXIBLE MEMBRANE FLG AND FASTENER SEAL PER MANUF, ANCHOR SECURELY 16" O.C. PER MANUF, TYPICAL
 - 25 EXTERIOR 6" x 18 GA GALV METAL STUDS, 16" O.C. W/CONT TRACK AT ENDS. NOTE: AT BLDGS "B & C", INSTALL STUD SUPPORT CLIPS AT EXIST CMU WALLS (WHERE OFFSET) TO MEET OR EXCEED STUD L/360 STIFFNESS RATIO.
 - 26 FLUID APPLIED VAPOR PERMEABLE MEMBRANE AIR BARRIER
 - 27 CONTINUOUS 2" RIGID INSULATION W/LAPPED EDGES, ANCHOR SECURELY TO WALL PER MANUF
 - 28 SPRAYED CELLULOSE INSULATION, FILL STUD DEPTH & ALL CAVITIES AT INSULATED WALLS, PROVIDE SUPPORT BLOCKING AS REQUIRED BY MANUF
 - 29 5/8" GYPSUM WALLBOARD, REFER TO LIFE SAFETY PLAN FOR RATED GWB LOCATIONS
 - 30 5/8" GYPSUM WALLBOARD CEILING ON 1-1/2" x 18 GA HAT CHANNELS, 24" O.C. WITH R-30 SPRAYED CELLULOSE INSULATION ABOVE, ANCHOR CHANNEL SECURELY AT EACH EXISTING ROOF TRUSS JOIST. (NOTE: AT 48" O.C., ANCHOR CHANNELS SECURELY WITH ONE S.S. ALL-THREAD ROD 24" x 3/8" DIA AND TWO STRUC S.S. NUTS WITH PLATE WASHERS SIZED FOR INSTALLATION NEAR TRUSS PANEL POINTS BETWEEN JOIST BARS OR ANGLES AT BOTTOM CHORD - HANG REMAINDER OF ROD BELOW CEILING FOR FULL SUPPORT OF LOWER CEILING, MEP SYSTEMS, SEISMIC OR OTHER BRACING, APPURTENANCES & OTHER LOADS).
 - 31 CONTINUOUS SEALANT AND BACKER ROD
 - 32 FINISH CEILING, RE: REFLECTED CEILING PLAN
 - 33 NEW STRUC SUPPORT MEMBER, RE: STRUC
 - 34 EXTERIOR 3 5/8" x 18 GA GALV METAL STUDS, 16" O.C. W/CONT TRACK AT ENDS
 - 35 INTERIOR 3 5/8" x 20 GA GALV METAL STUDS, 16" O.C. W/CONT TRACK AT ENDS
 - 36 INTERIOR 7/8" x 20 GA GALV METAL HAT CHANNELS, 16" O.C.
 - 37 GALVANIZED ADJUSTABLE ANCHORING SYSTEM AT MET WALL PANEL JOINT CLIPS & ON PANEL FACE BETWEEN. INSTALL PER MET WALL PANEL MANUFACTURER'S WARRANTED SYSTEM
 - 38 EXTERIOR 8" x 18 GA GALV METAL STUDS, 16" O.C. W/CONT TRACK AT ENDS.
 - 39 EXISTING ROOF TO REMAIN
 - 40 EXISTING STRUCTURE TO REMAIN
 - 41 EXISTING MASONRY WALL TO REMAIN
 - 42 NEW LINTEL(S)
 - 43 HOLLOW METAL FRAME
 - 44 INSULATED HOLLOW METAL DOOR
 - 45 METAL THRESHOLD - SET IN SEALANT BED
 - 46 MEMBRANE FLASHING
 - 47 SYNTHETIC SILL - BULLNOSE EDGE
 - 48 PREFINISHED METAL SILLS
 - 49 FLOOR FINISH
 - 50 BASE
 - 51 VAPOR BARRIER (10 MIL MINIMUM THICKNESS)
 - 52 VOID FORMS, REFER TO STRUCTURAL
 - 53 INTERIOR FURRING: 5/8" GWB ON 2 1/2" x 20 GA GALV METAL FRAMING, 16" O.C. W/CONT TRACK AT ENDS
 - 54 CONT 3/4" TREATED EXTERIOR PLYWOOD SHEATHING OR DECKING
 - 55 CONCRETE SLAB ON 10 MIL VAPOR BARRIER & MIN 4" COMPACTED DRAINAGE FILL, RE:STRUC

<div>Revisions:</div> <div>Date</div>		<div>CONSULTANTS:</div>		09/07/2012	<div>ARCHITECT / ENGINEERS:</div>		<div>Drawing Title</div> <div>WALL SECTIONS</div>		<div>Project Title</div> <div>Renovate Leroy Pond Army Reserve Center for Mental Health Residential Rehabilitation Treatment/ Police Training</div>		<div>Project Number</div> <div>564-341</div>
							<div>Approved: Project Director</div> <div></div>		<div>Location</div> <div>Fayetteville, AR</div>		<div>Building Number</div> <div></div>
									<div>Date</div> <div>9/7/12</div>		<div>Drawing Number</div> <div>AE306</div>
									<div>Checked</div> <div>SG</div>	<div>Drawn</div> <div>PQ</div>	<div>Dwg. 65 of 126</div>

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